


OE{ æë[Á[• ãṛæáæ Áæ• á̃ [Á æã ^} d ÁÔ à^|č |æÁÖā[ÁD

escala 1:50

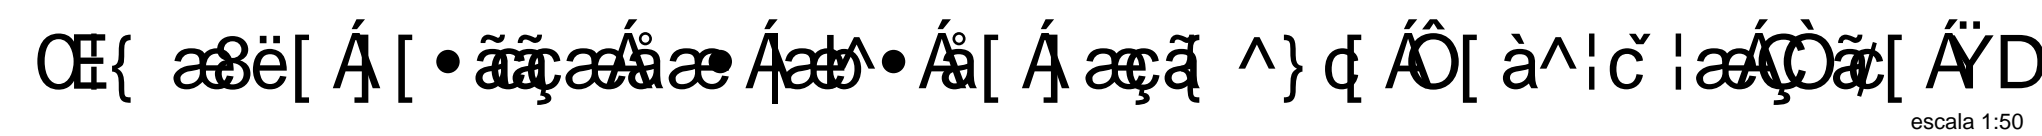

Ø U	DIAM (mm)	C.TOTAL (m)	PESO + 10 % (kg)
CA50	6.3	2510.9	675.9
	8.0	264.1	114.6
CA60	5.0	148.7	25.2
PESO TOTAL (kg)			

Technical drawing of a building floor plan showing a grid of columns and beams. The plan includes labels for columns (L1 to L10) and beams (34 NT, 31 NB, 38 NT, 39 NT). To the right of the plan are two tables: 'Negativos X' and 'Positivos X' for beam C-370, and 'Positivos Y' for beam C-272. Below these tables is a section line L1-L10 and a table for the section properties.

Ø U	N	DIAM (mm)	QUANT	C. UNIT (cm)	C. TOTAL (cm)
CA60	1	5.0	57	125	7125
	2	5.0	102	42	4284
	3	5.0	29	43	1247
CA50	4	5.0	15	147	2205
	5	6.3	148	642	95016
	6	6.3	26	659	17134
	7	6.3	302	370	111740
	8	6.3	100	272	27200
	9	8.0	3	294	2352
	10	8.0	3	131	393
	11	8.0	6	92	552
	12	8.0	36	642	23112

Ø U	N	DIAM (mm)	QUANT	C. UNIT (cm)	C. TOTAL (cm)
CA60	1	5.0	57	125	7125
	2	5.0	102	42	4284
	3	5.0	29	43	1247
CA50	4	5.0	15	147	2205
	5	6.3	148	642	95016
	6	6.3	26	659	17134
	7	6.3	302	370	111740
	8	6.3	100	272	27200
	9	8.0	3	294	2352
	10	8.0	3	131	393
	11	8.0	6	92	552
	12	8.0	36	642	23112

Ø U	N	DIAM (mm)	QUANT	C. UNIT (cm)	C. TOTAL (cm)
CA60	1	5.0	57	125	7125
	2	5.0	102	42	4284
	3	5.0	29	43	1247
CA50	4	5.0	15	147	2205
	5	6.3	148	642	95016
	6	6.3	26	659	17134
	7	6.3	302	370	111740
	8	6.3	100	272	27200
	9	8.0	3	294	2352
	10	8.0	3	131	393
	11	8.0	6	92	552
	12	8.0	36	642	23112

Section line L1-L10

Ø U	DIAM (mm)	C. TOTAL (m)	PESO + 10 % (kg)
CA50	6.3	2510.9	675.9
CA60	8.0	264.1	114.6
CA50	5.0	146.7	25.2
PESO TOTAL (kg)			
CA50	790.5		
CA60	25.2		